Drawing Index

These sheets are a document set and should not be separated. Electrical information and references are contained on all sheets.

SITE READINESS

C1

EQUIPMENT LAYOUT

(Equipment locations, heat loads, component weights, environmental specs)

STRUCTURAL LAYOUT

51

(Structural support/mounting locations for floor/wall/ceiling, wall support elevations)

STRUCTURAL DETAILS

S2

(Floor and Ceiling loading information)

ELECTRICAL LAYOUT

(Contractor supplied wiring, interconnect methods, junction point locations and descriptions)

ELECTRICAL SPECIFICATIONS

(Maximum wiring run lengths, interconnect diagram, system power specifications)

ELECTRICAL DETAILS

E3

EQUIPMENT DETAILS

D1

These equipment IS drawings indicate the placement and interconnection of the listed equipment components. These drawings are not construction or site preparation drawings. Customer remains ultimately responsible for preparing the site to accommodate the IS and operation of such equipment in compliance with GE Healthcare's written specifications and all applicable federal, state, and/or local requirements.

* REQUIRED REFERENCE *

PARTIAL UPS CT & PET

Pre Installation Manual

N/A

A mandatory component of this drawing set is the GE Healthcare Pre Installation manual. Failure to reference the preIS manual will result in incomplete documentation required for site design and preparation.

Pre Installation documents for GE Healthcare products can be accessed on the web at:

www.gehealthcare.com/siteplanning

GE Healthcare



CT Site Planning



Customer Site Readiness Requirements

- Any deviation from these drawings must be communicated in writing to and reviewed by your local GE Healthcare Installation Project Manager prior to making changes.
- Make arrangements for any rigging, special handling, or facility modifications that must be made to deliver the equipment to the installation site. If desired, your local GE Healthcare Installation Project Manager can supply a reference list of rigging contractors.
- New construction requires the following; 1. Secure area for equipment,
 2. Power for drills and other test equipment,
 3. Capability for image analysis,
 4. Restrooms.
- Provide for refuse removal and disposal (e.g. crates, cartons, packing)
- Contact a radiation physicist or consultant to specify radiation containment requirements.

GE Equipment Delivery Requirements

The items on the GE Healthcare Site Readiness Checklist are REQUIRED to facilitate equipment delivery to the IS site. Equipment will not be delivered if these requirements are not satisfied.

	GE Healthcare Site R	eadir	ness (Check	dist	
	GEHC Global Order #: Cu	ustomer:				
	GEHC Global Order #: Ct GEHC PMI: FE /	Installer:				
The customer is responsible for proper site preparation regardless of any GEHC measurements/inspections/assessments.						
Inspection Date:						
Item #	GEHC Minimum Requirements	Storage: Is item ready?	PMI Is item ready?	FE Is item ready?	Comments If "N", enter comments or action plan	
1	MR Magnet Delivery Requirements: Ensure cryogen venting system is designed and installed with objective evidence that it is compliant with the GEHC Pre-Installation Manual (PIM) requirements, exhaust fan system is installed and operational, 480V power, and chilled water supply is available 24x7 that meets system cooling requirements. External connectivity is available for magnet monitoring and phone service is available during delivery.					
2	MR RF Screen Room Requirements: RF Screen Room is tested with objective evidence that it is compliant with GEHC specifications.					
3	Site Drawing Requirements: Final version of equipment installation drawings (including red lined versions) verified to match actual room and has been provided to installer. X-ray shielding plan and state acknowledgment letter provided to installer for AR, DC, NC, SC & WA.					
4	Surface Penetration Requirements: Customer/Contractor scheduled to provide required drilling or cutting into floors, ceilings, and walls; OR surface penetration permit available and posted in the room when GEHC will perform the work.					
G	Delivery Route Requirements: The equipment delivery route from the truck to the final destination within the facility has been reviewed with all key stakeholders to safely meet the minimum requirements for equipment access, and all communications/notifications have occurred. Amangements have been made for special handling (elevator, rigging, floor protection, fork lift, rollback truck, etc).					
6	Finished Room Requirements: Rooms that will contain equipment, including storage areas not in scan suite, are dust free. Provisions taken to maintain a dust free room. Precautions must be taken to prevent dust from entering rooms containing equipment when construction is incomplete in adjacent areas. All walls primed (final coat not needed on Day 1). No contractor work being done during or after the installation that will cause dust in the installation areas or potential equipment damage. Room security to prevent unauthorized access and theft has been discussed with customer. The customer is aware of these security issues, implications and responsibility. For Storage: Room must meet PIM requirements for storage.					
7	Electrical Requirements: Main Disconnect Panel (MDP) is installed and system power is available. Conduits, electrical cable ducting/dividers/cable trays, and access flooring is installed in proper location and height. Surface floor duct and load-side wires can be installed at time of system installation.					
8	HVAC Requirements: The HVAC/Chilled Water systems designed to maintain the environment are running and appear to provide the desired environmental conditions (temperature and humidity) for system operation.					
9	Flooring Requirements: Floor is clean and prepared for final floor covering. Floor levelness/flatness is measured and within tolerance, and there are no visible defects per GEHC specifications.					
10	Ceiling Requirements: Unistrut (or equivalent) location, levelness and spacing is measured (or vendor confirmed) and consistent with the requirement of the installation drawings. Ceiling grid is installed. Permanent lighting is installed and operational. HVAC diffusers are installed and connected to ductwork. Ceiling tiles installed per PMI discretion.					

E Healthcare

TYPE: CT & PET PARTIAL UPS

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ATED APPARATUS, ELECTRICAL WIRING DETAILS AND ROOM ARRANGEM
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EQUIPMENT EXPECTED TO BE INSTALLED. IT IS NOT TO BE USED F

PROJECT TILE:

TO SET PARTIAL UPS

TYPICAL FINIAL

PROJECT REVISION

TYPUPS 01

DATE: 27.Jul.12

DRAWN BY: JGA

CHECKED BY: JGA

REVISION	HISTORY:	



GE EQUIPMENT LISTING	SCALE: $1/4" = 1'-0"$ EQUIPMENT LAYOUT RECOMMENDED CEILING HEIGHT = $9'-0"$	ANCILLARY ITEMS	
EQUIPMENT ON ORDER FROM GE HEALTHCARE, INSTALLED BY GE HEALTHCARE, EQUIPMENT CROSS	This equipment layout indicates the placement and interconnection of the indicated equipment components. There may be federal, state, and/or local requirements that could impact the placement of these components. It remains the Customer's responsibility for ensuring the site and final equipment placement complies with all applicable federal, state, and/or local requirements.	CUSTOMER/CONTRACTOR SUPPLIED AND INSTALLED	nsin
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		o RADIATION PROTECTION REQUIREMENTS ARE NOT INDICATED ON THIS PLAN. WHERE NEEDED PER NATIONAL OR LOCAL CODE THEY SHALL BE SPECIFIED BY A QUALIFIED	\bigcirc
		RADIOLOGICAL PHYSICIST.	
		THE DEVELOPMENT OF THE EQUIPMENT LAYOUT, ROOM DIMENSIONS, MECHANICAL AND ELECTRICAL SUGGESTIONS IS PREDICATED UPON THE BEST INFORMATION OBTAINABLE FROM THE SITE COURLED WITH THE CUSTOMER'S KNOWN DESIRES. APCHIECTURAL OR	\supset
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		DRAWING IS ALLOWED ONLY WITH NOTIFICATION, IN WRITING, AND REVIEW BY GEHC SERVICE DEPARTMENT. EQUIPMENT OPERATION, SERVICEABILITY, AND RESTRICTING CABLE LENGTHS, ETC., MAKE THIS ESSENTIAL FOR A PROPER IS. GEHC RESERVES	\equiv
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		o DIMENSIONS ARE TO FINISHED SURFACES OF ROOM	
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THE FOLLOWING ITEMS, WHICH HAVE BEEN ORDERED FROM GE HEALTHCARE, ARE TO BE INSTALLED BY THE CUSTOMER OR HIS CONTRACTOR.			PROJECT REVISION TYPUPS 01
			DATE: 27.Jul.12
		MAGNETIC INTERFERENCE SPECIFICATIONS	DRAWN BY: JGA
			CHECKED BY: JGA
			REVISION HISTORY:
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THIS SHEET IS PART OF THE DOCUMENT SET LISTED ON SHEET C1 AND SHOULD NOT BE SEPARATED

TYPICAL WALL SUPPORT ELEVATIONS	SCALE: 1/4" = 1'-0" STRUC	CTURAL LAYOUT	RECOMMENDED CEILING HEIGHT = 9'-0"	STRUCTURAL SUPPORT METHODS	
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				STRUCTURAL NOTES	
				ALL STEEL WORK AND PARTS NECESSARY TO SUPPORT CEILING MOUNTED EQUIPMENT IS TO BE SUPPLIED BY THE CUSTOMER OR HIS CONTRACTORS. METHODS OF SUPPORT FOR THE STEELWORK THAT WILL PERMIT ATTACHMENT TO STRUCTURAL STEEL OR THROUGH BOLTS IN CONCRETE CONSTRUCTION SHOULD BE	
				FAVORED. DO NOT USE CONCRETE OR MASONRY ANCHORS IN DIRECT TENSION. O ALL UNITS THAT ARE WALL MOUNTED OR WALL SUPPORTED ARE TO BE PROVIDED WITH SUPPORTS WHERE NECESSARY, WALL SUPPORTS ARE TO BE SUPPLIED AND INSTALLED BY	
				THE CUSTOMER OR HIS CONTRACTORS. SEE PLAN AND DETAIL SHEETS FOR SUGGESTED LOCATIONS AND MOUNTING HOLE LOCATIONS. O ALL CEILING MOUNTED FIXTURES, AIR VENTS, SPRINKLERS, ETC. TO BE FLUSH MOUNTED, OR SHALL NOT EXTEND MORE THAN 1/4" BELOW THE FINISHED CEILING.	
				FLOOR SLABS ON WHICH EQUIPMENT IS TO BE INSTALLED MUST BE LEVEL TO 1/8" in 10'-0" DIMENSIONS ARE TO FINISHED SURFACES OF ROOM.	PROJECT III
				CUSTOMERS CONTRACTOR MUST PROVIDE ALL PENETRATIONS IN POST TENSION FLOORS. CUSTOMERS CONTRACTOR MUST PROVIDE AND INSTALL ANY NON-STANDARD ANCHORING. DOCUMENTS FOR STANDARD ANCHORING METHODS ARE INCLUDED WITH GE EQUIPMENT DRAWINGS FOR GEOGRAPHIC AREAS THAT REQUIRE SUCH DOCUMENTATION.	PROJECT REVISION
				CUSTOMERS CONTRACTOR MUST PROVIDE AND INSTALL HARDWARE FOR "THROUGH THE FLOOR" ANCHORING AND/OR ANY BRACING UNDER ACCESS FLOORS. THIS CONTRACTOR MUST ALSO PROVIDE FLOOR DRILLING THAT CANNOT BE COMPLETED BECAUSE OF AN OBSTRUCTION ENCOUNTERED WHILE DRILLING BY THE GE INSTALLER SUCH AS REBAR ETC.	TYPUPS 01 DATE: 27.Jul.12
				O IT IS THE CUSTOMER'S RESPONSIBILITY TO PERFORM ANY FLOOR OR WALL PENETRATIONS THAT MAY BE REQUIRED. THE CUSTOMER IS ALSO RESPONSIBLE FOR ENSURING THAT NO SUBSURFACE UTILITIES (E.G., ELECTRICAL OR ANY OTHER FORM OF WIRING, CONDUITS, PIPING, DUCT WORK OR STRUCTURAL SUPPORTS (I.E. POST TENSION)	DRAWN BY: JGA CHECKED BY: JGA
				CABLES OR REBAR)) WILL INTERFERE OR COME IN CONTACT WITH SUBSURFACE PENETRATION OPERATIONS (E.G. DRILLING AND INSTALLATION OF ANCHORS/SCREWS) PERFORMED DURING THE INSTALLATION PROCESS. TO ENSURE WORKER SAFETY, GE INSTALLERS WILL PERFORM SURFACE PENETRATION OPERATIONS ONLY AFTER THE CUSTOMER'S VALIDATION AND COMPLETION OF THE "GE SURFACE PENETRATION PERMIT"	REVISION HISTORY:
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THIS SHEET IS PART OF THE DOCUMENT SET LISTED ON SHEET C1 AND SHOULD NOT BE SEPARATED

GE Healthcare

SHEET TITLE: STRUCTURAL DETAILS

ODALITY TYPE: CT & PET PARTIAL UPS

AND ASSOCIATED APPARATUS, ELECTRICAL WIRING DETAILS AND ROOM ARRANGEMEN

IN PREPARING THIS PLAN, EVERY EFFORT HAS BEEN MADE TO CONFORM DETAILS

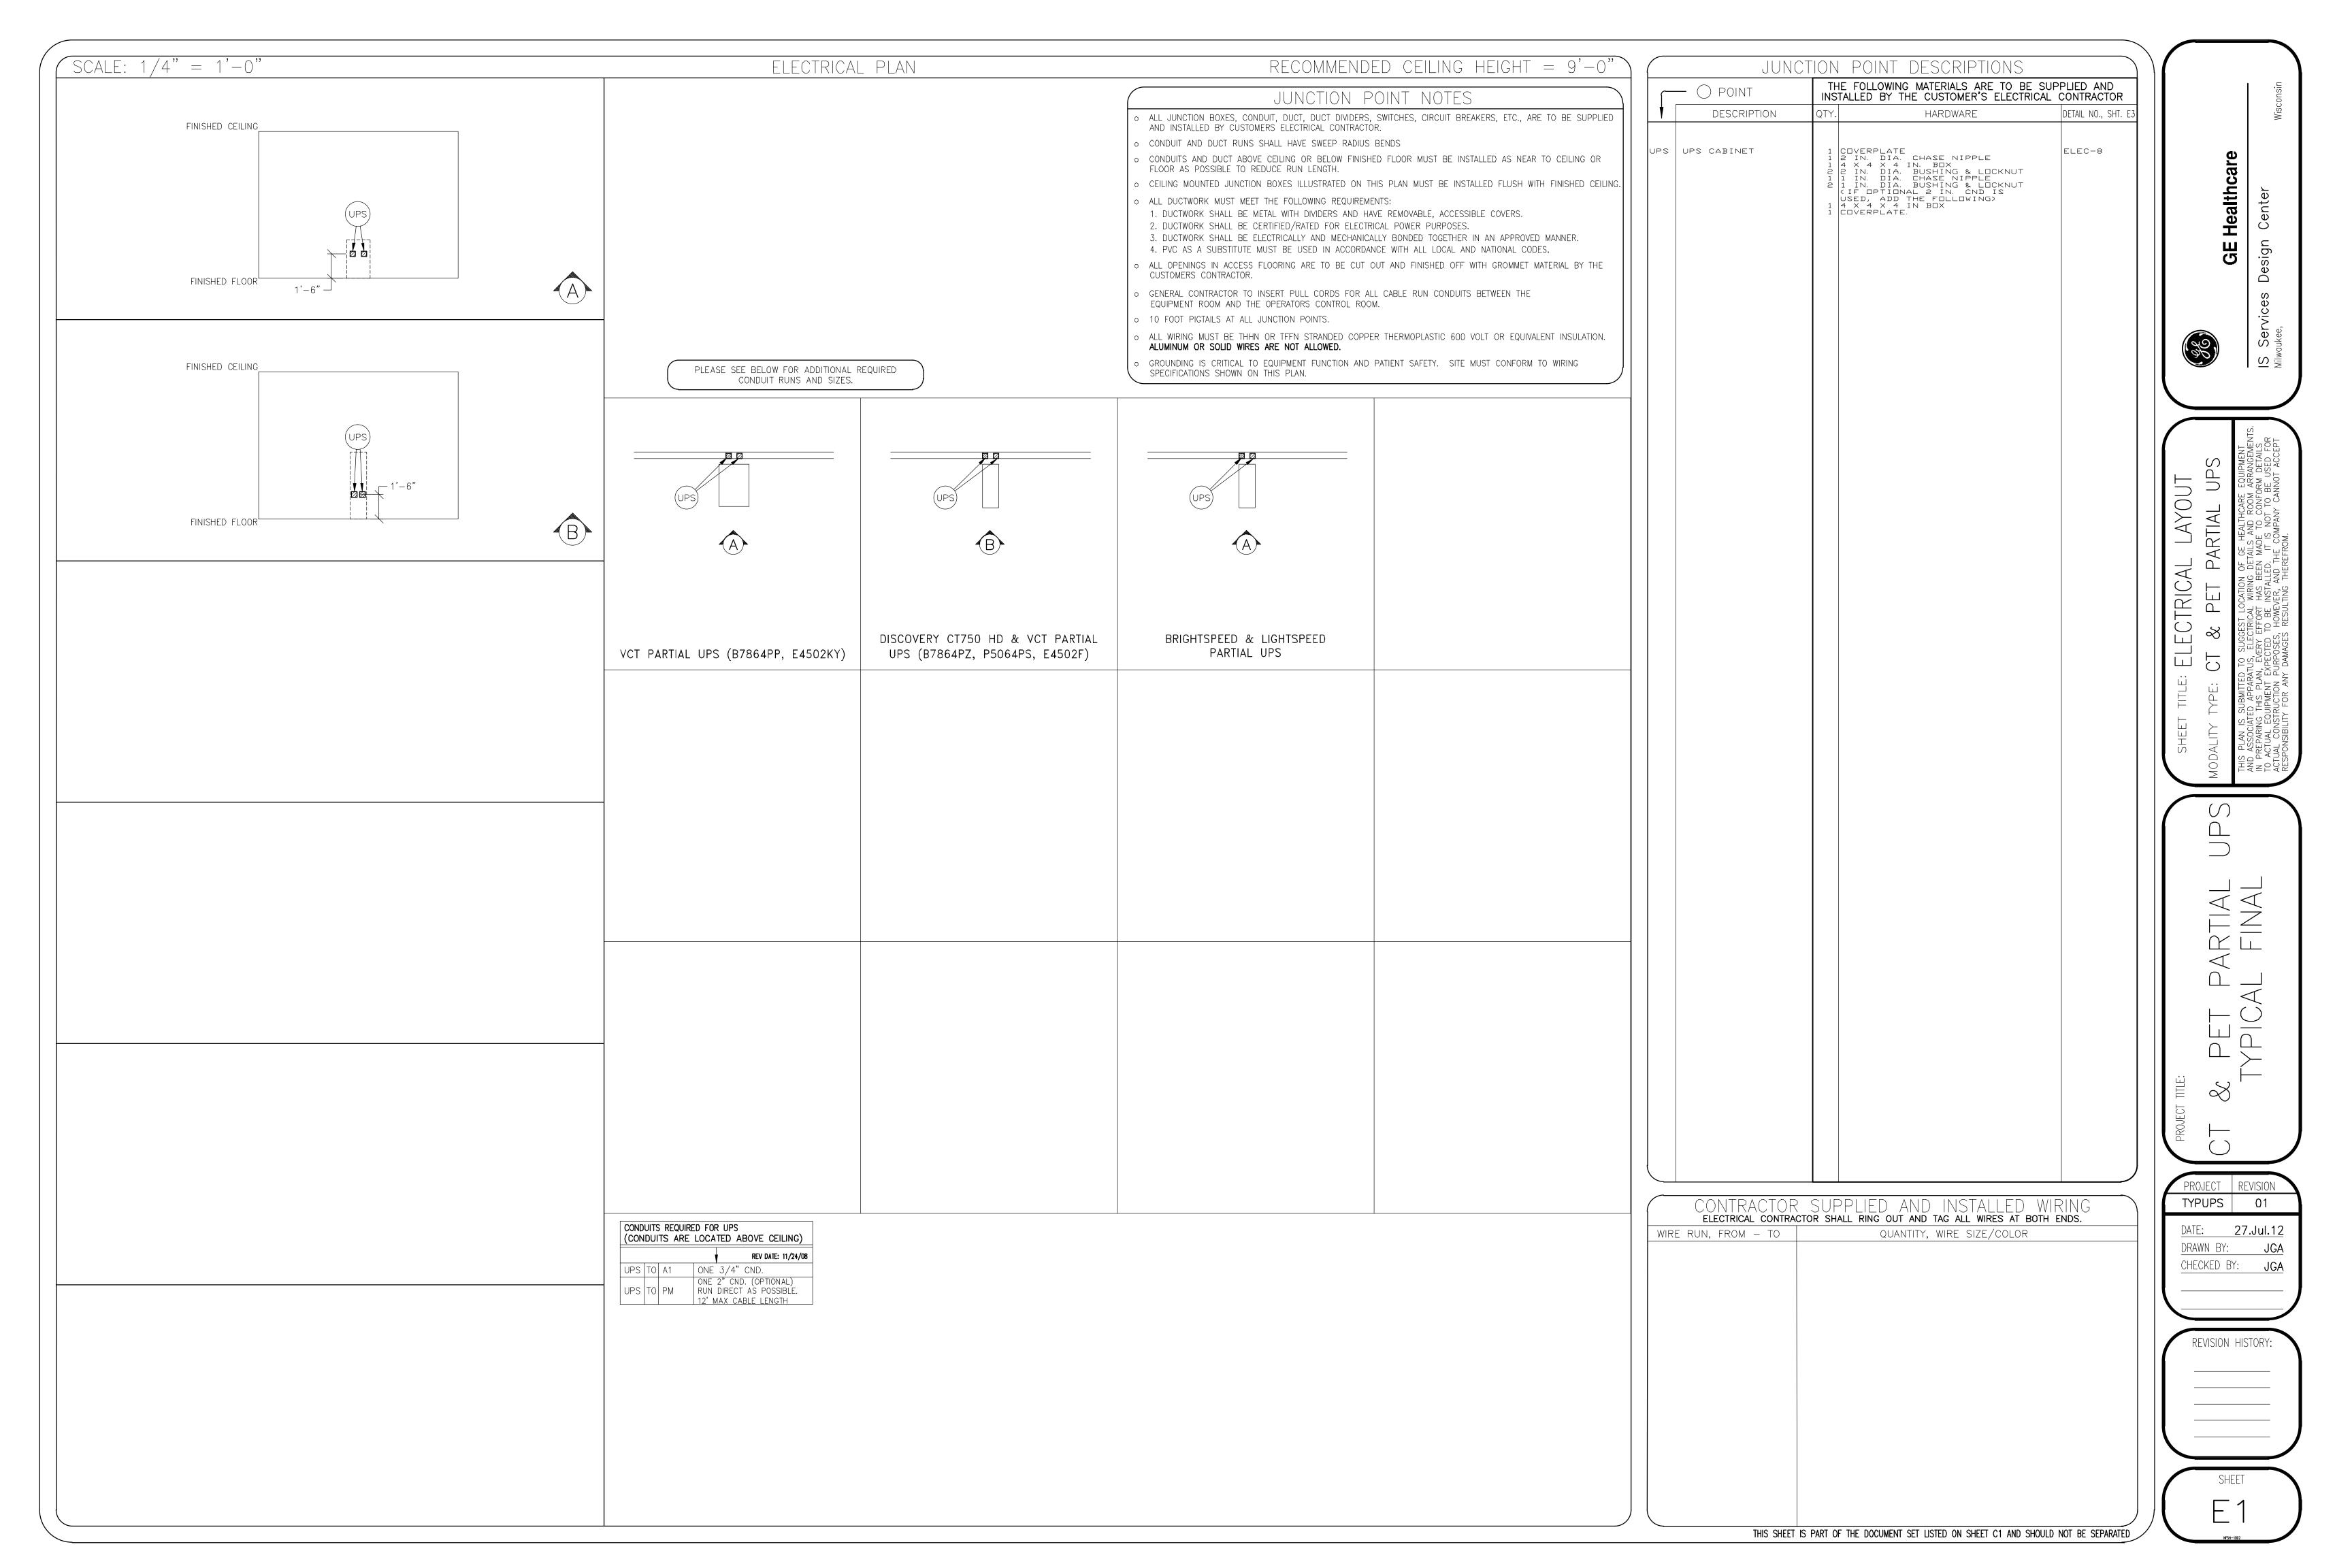
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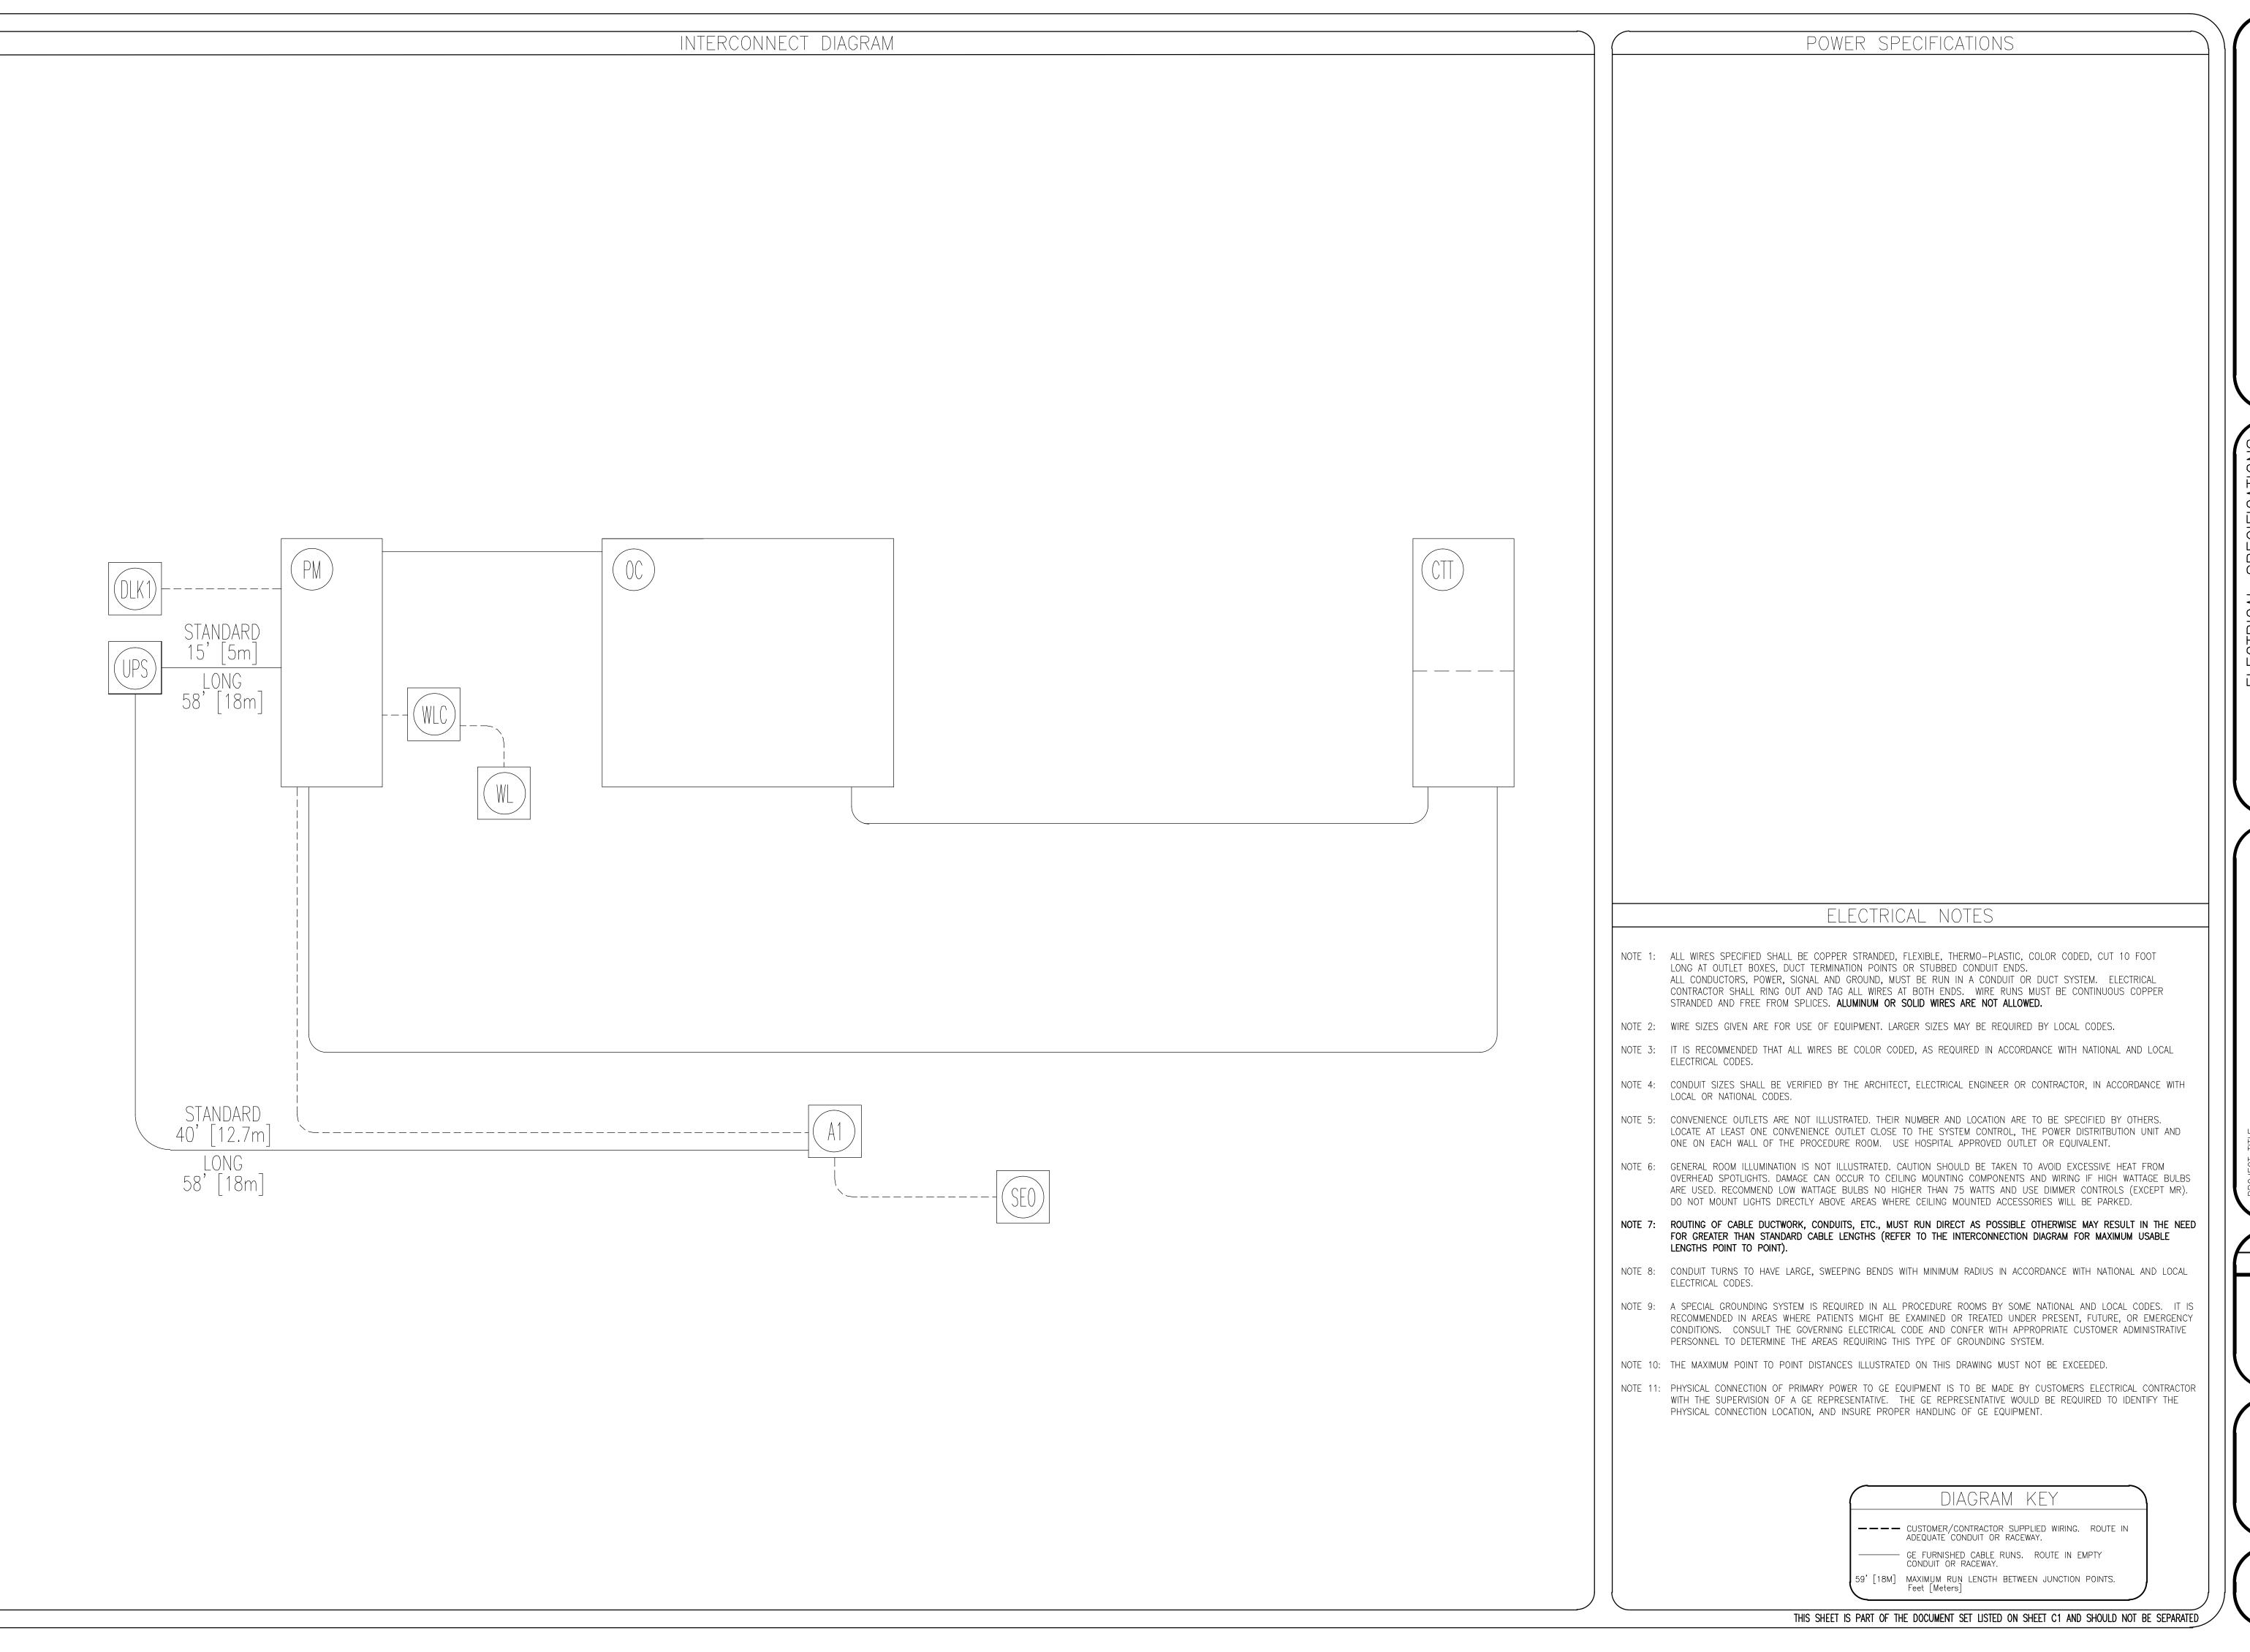
RESPONSIBILITY FOR ANY DAMAGES RESULTING THEREFROM.

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CHECKED BY: JGA





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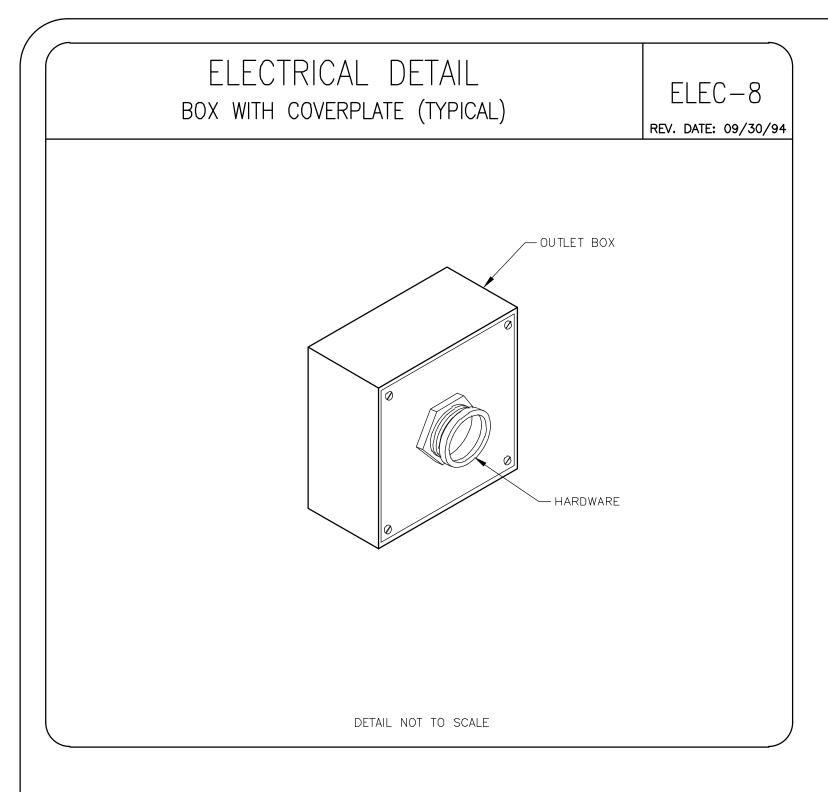
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PROJECT REVISION TYPUPS 01

DATE: **27.Jul.12** DRAWN BY:

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TITLE: ELECTRICAL DETAILS

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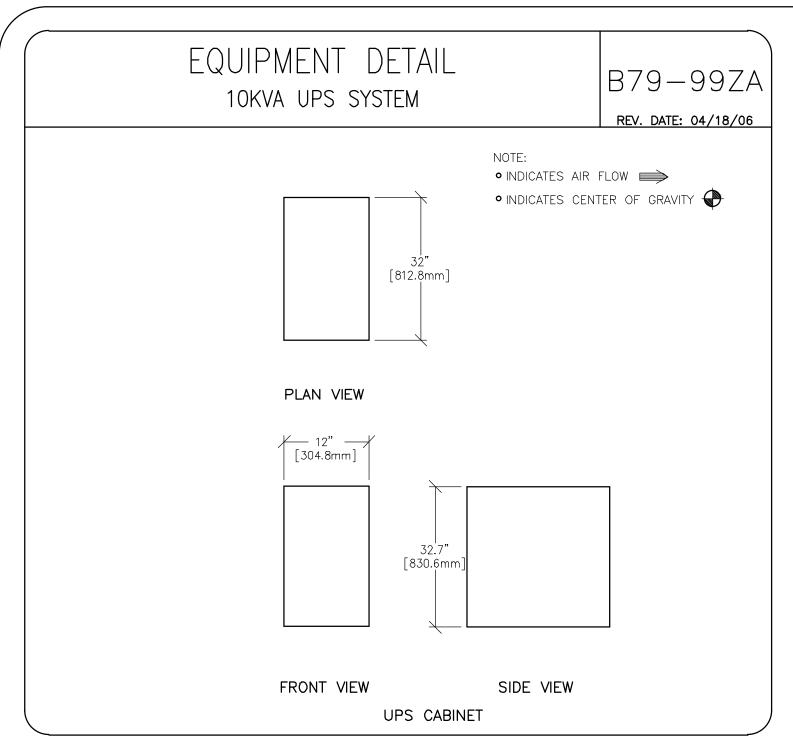
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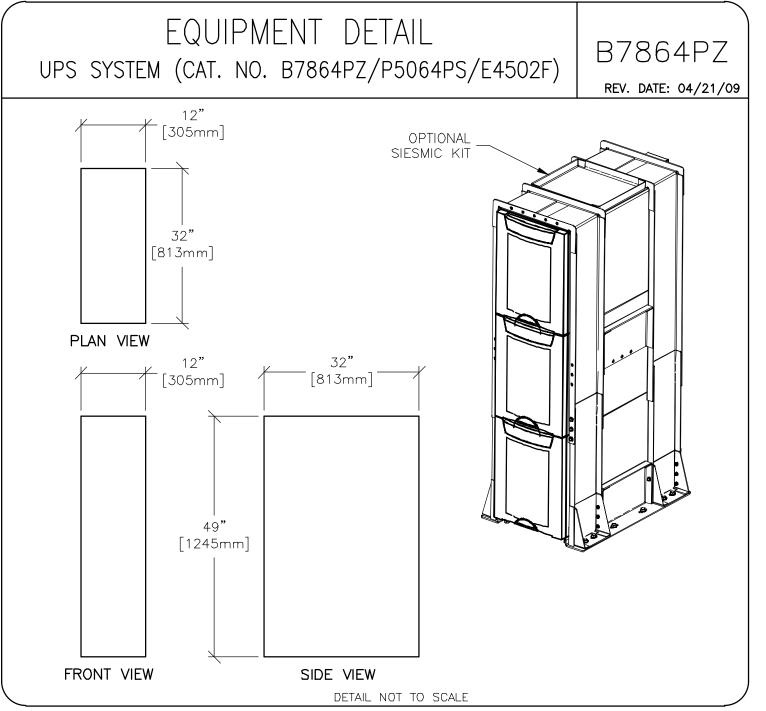
GE Healthcare

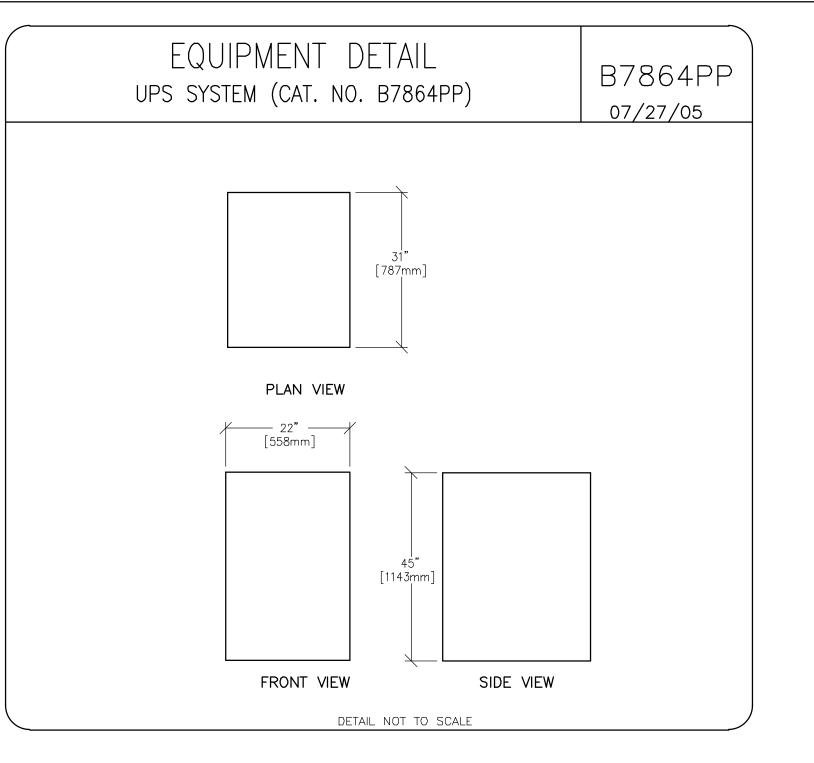
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E: EQUIPMENT DETAILS E: CT & PET PARTIAL UPS

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